
SVFUDS PSB HILLSIDE REMEDIATION STATUS AUGUST 2023

Weston Solutions, Inc. August 8, 2023





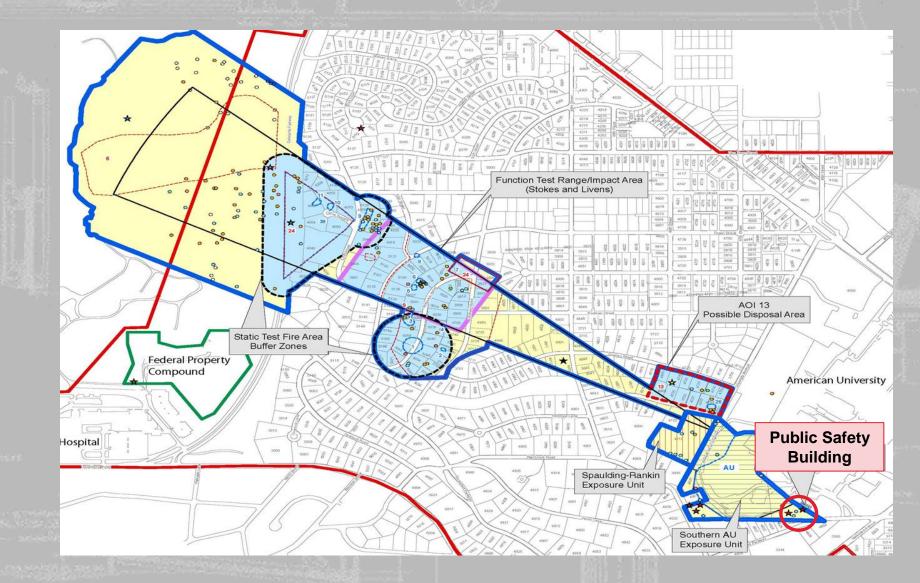

PUBLIC SAFETY BUILDING UPDATE



- Weston demobilized from the PSB on 16 April 2021.
- PSB Confirmation Sample results met all SVFUDS cleanup criteria.
- Completed E&S Control Inspections every other week April – present.
- PSB slope and soil benches are vegetated and stable.
- Mowing & Fence repairs ongoing.





PUBLIC SAFETY BUILDING STATUS & SCHEDULE



- The Draft Final PSB Under Foundation Remediation Property Report was submitted for Spring Valley Partners' review in early 2023.
- USACE awarded PSB Hillside remediation to Weston on March 9, 2023.
- Draft Final UFP-QAPP PSB Hillside Work Plan was submitted for Spring Valley Partners' review on July 7, 2023.
- Start of Field Team mobilization is currently planned for Tuesday September 5, 2023, after Labor Day.
- Retaining wall work is scheduled to start on September 18th.
- Excavation & Backfill work is scheduled to start in late September 2023 and continue through May 2024. Team will take Holiday breaks.



AUES DEBRIS LAYER & EXAMPLE ITEMS






Photo of North Wall of PSB Foundation Excavation with yellow box showing Black AUES Debris layer about 1 foot below the former PSB basement slab elevation. During the PSB Foundation excavation, AUES Debris was observed extending beyond the excavation wall.

Examples of AUES Debris recovered: broken glass, glass jars, test tubes, ceramics, and metal pieces. No CWA was detected. One area had elevated metals in the soil and one test tube was found with possible TNT - both were removed.

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PSB HILLSIDE PROPOSED EXCAVATION EXTENT



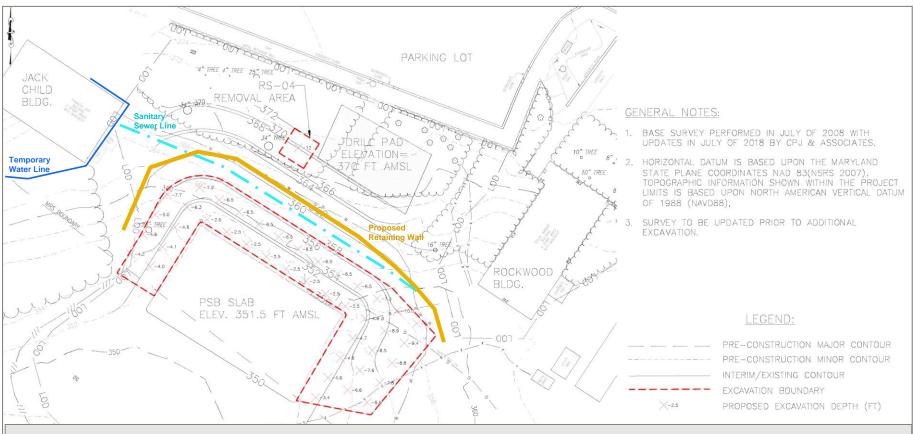

USACE contracted with Weston to investigate the extent of this AUES debris layer. Weston conducted test pitting and Rotosonic drilling to delineate the extent of the debris outside the former PSB Foundation. Inferred AUES Debris extent is shown by dashed red lines.

20' 0	20'	40'	PLAN	AMERICAN UNIVERSITY PUBLIC SAFETY BUILDING SITE	FIGURE 3: EXCAVATION EXTENTS
SCALE	1"=20'-0"		SCALE: 1"=20'-0"	WALSSIGN SOLUTIONS	DRAWN DATE DES. ENG. DATE CHECKED 5/18/21 LB 5/18/21 CHECKED DATE 5/18/21 CH 5/18/21 DATE



PSB HILLSIDE - EXCAVATION PROCESS




- Mobilize equipment & staff to the PSB Hillside Site.
- Site Setup including utility clearance, sanitary sewer bypass, erosion & sediment control installations, soil sorting pad and AUES Debris staging area.
- Install Retaining Wall Piles and Tiebacks.
- Excavate clean soil on Hillside and add wood lagging as we dig down. Transport soil to/from Federal Compound in Dump Trucks.
- Mobilize UXO crew once we encounter the AUES Debris layer.
- Excavate, monitor, sort, sample, & load AUES Debris impacted soil into Roll-offs.
- Transport full Roll-offs to the Federal Compound and store there pending lab sample results and waste profile approval.
- Remove all AUES Debris, excavate 1 extra foot, collect soil confirmation samples, backfill excavation with approval by USACE.
- Re-build PSB Hillside slope, seed & water, then prepare Site Restoration Plan.
- Restore site in accordance with approved Site Restoration Plan & Demobilize.



PSB HILLSIDE REMEDIATION SITE PLAN




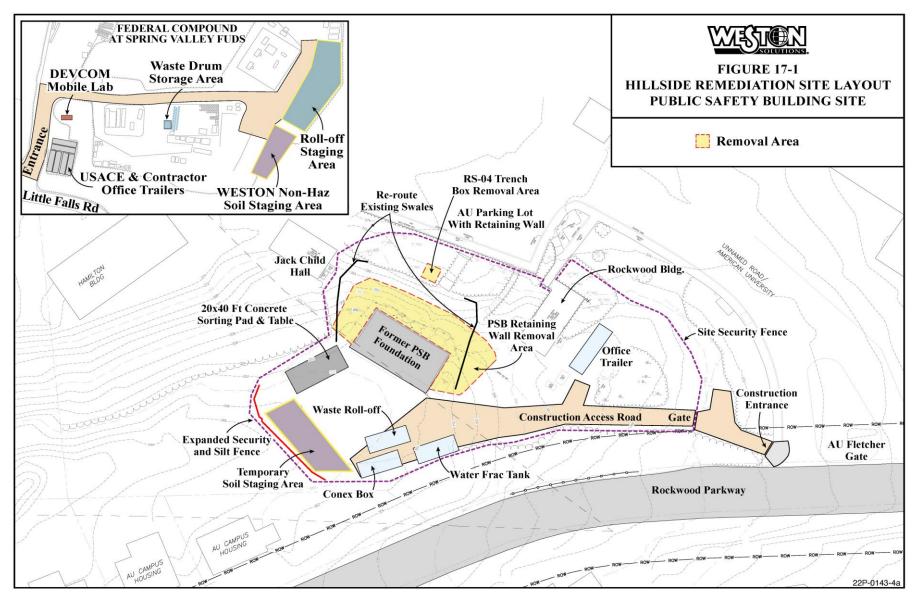

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PSB HILLSIDE RETAINING WALL INSTALLATION





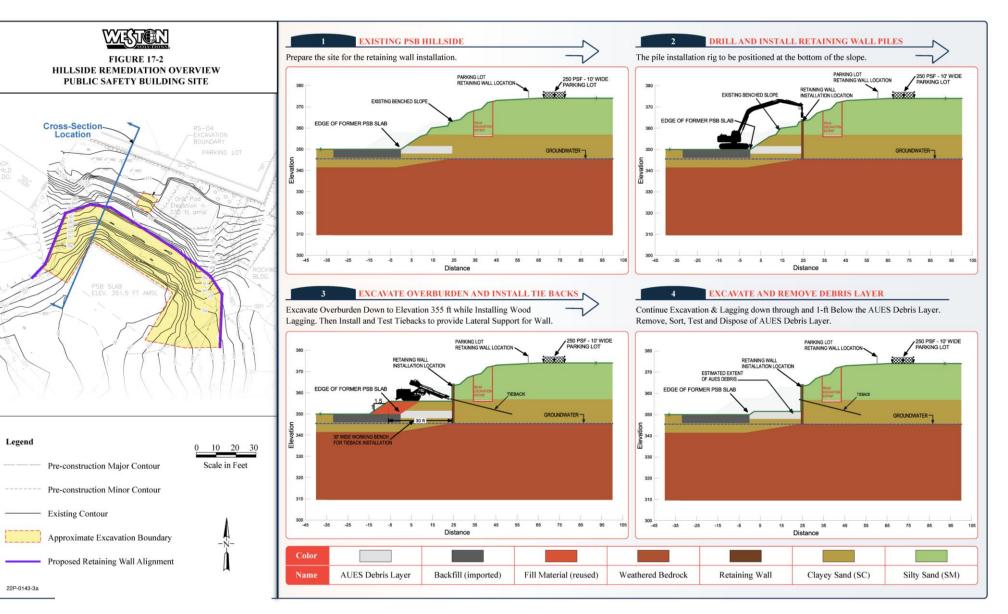

PSB HILLSIDE RETAINING WALL DETAILS





Install ~14 ft Retaining Wall from elevation 362 ft down to 348 ft and excavate approx. 560 CY of Debris

- Safety Fence OSHA required safety fence at top of retaining wall.
 Tiebacks – set in angled borings and cemented in place to anchor the wall into the slope.
- Wood Lagging installed by hand behind the front lip of the "H" piles to hold back the soil.
- "H" Piles set in drilled holes and cemented in place. Designed to hold wood lagging boards.



PHOTOS OF PREVIOUS REMEDIATION WORK



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Construction Entrance



Tree Protection



Sorting AUES Debris



Loading Soil in Roll-Off




Overview of Previous Remediation Operations

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TRAFFIC CONTROL PLAN & TRUCK ROUTE



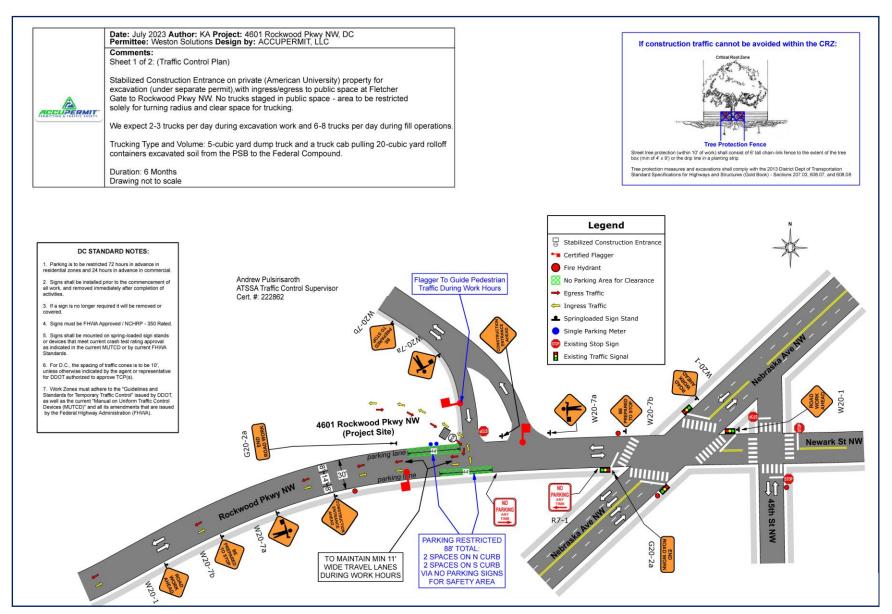

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PROJECT SAFETY - IMPACT - MONITORING



WESTON and the U.S. Army will be monitoring the site to ensure safety and minimize impacts to the AU community and local residents:

- Air monitoring for chemical warfare agent at the site perimeter and at the excavation zone. Dust monitoring at the perimeter of the site.
- Air monitoring for metals and organic vapor at the excavation zone and worker's breathing zone.
- Noise monitoring conducted during operations no pile driving. Work hours 6:30 am to 7 pm Monday – Friday (also Saturday, if needed).
- Building and parking lot wall foundation monitoring using laser level survey equipment to ensure there is no impact/movement caused by the excavation.
- Traffic control staff to manage truck, car & pedestrian traffic at the Fletcher Gate.
- Truck & Excavation equipment tire wash/inspection prior to release to Rockwood Parkway to eliminate dirt on the street.
- Security Fence, privacy fabric



FINAL RESTORATION GRADING PLAN











Please contact Dan Noble with any questions or concerns.

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